




# PROP. FORTH FLOOR PLAN


**SCALE 1:100** 

(FOR FULLY TENANT & OWNER ACCOMMODATION)

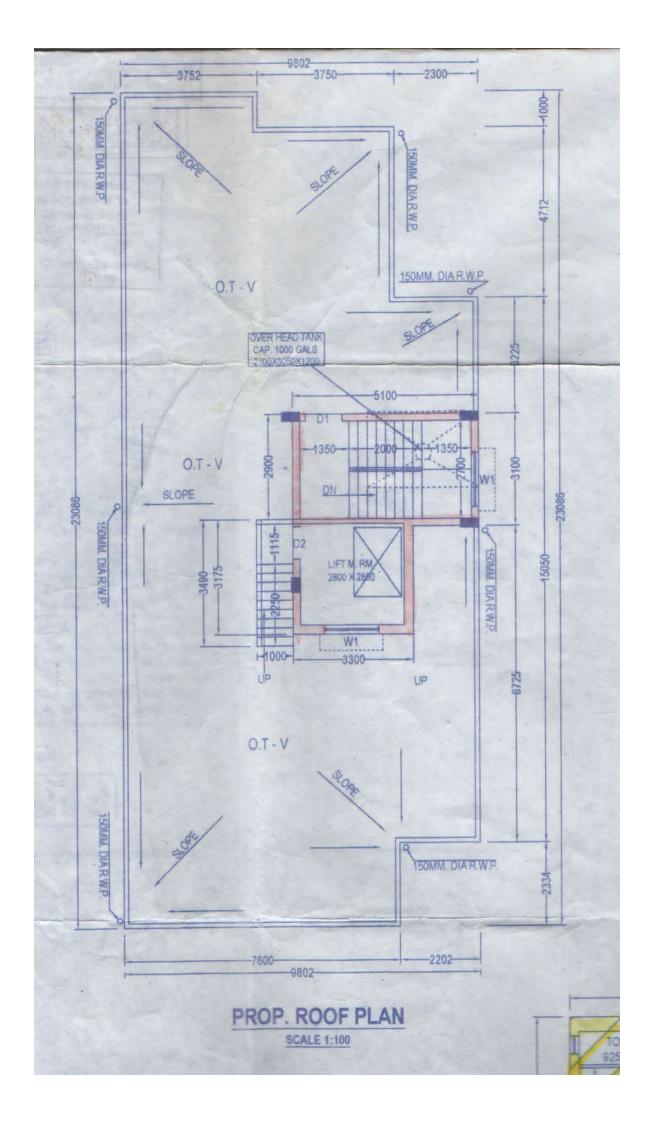

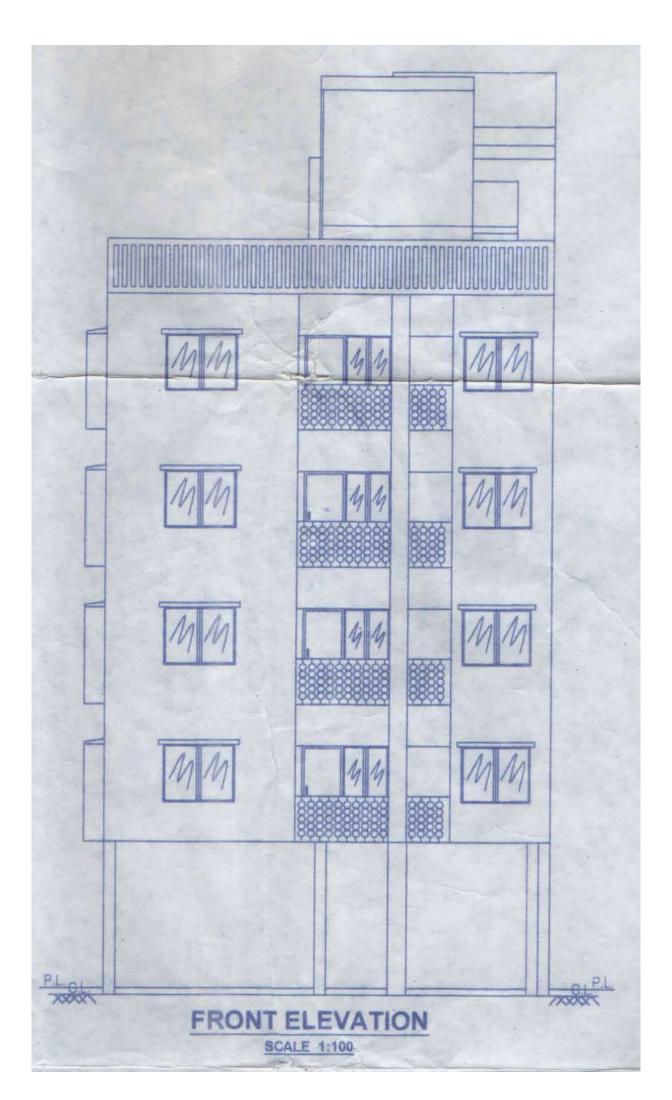

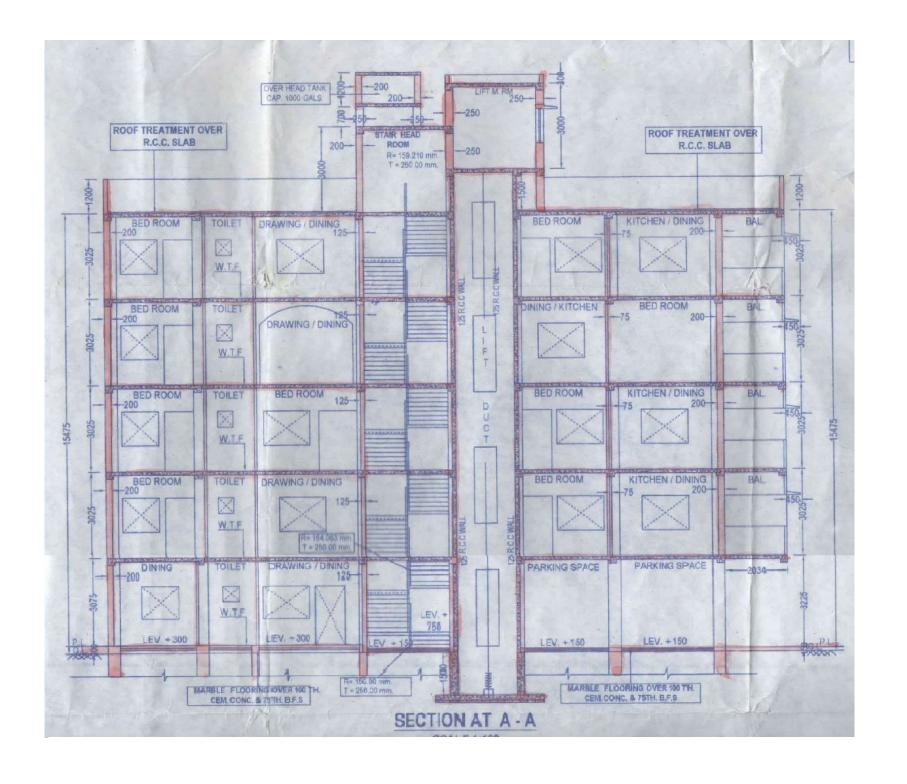

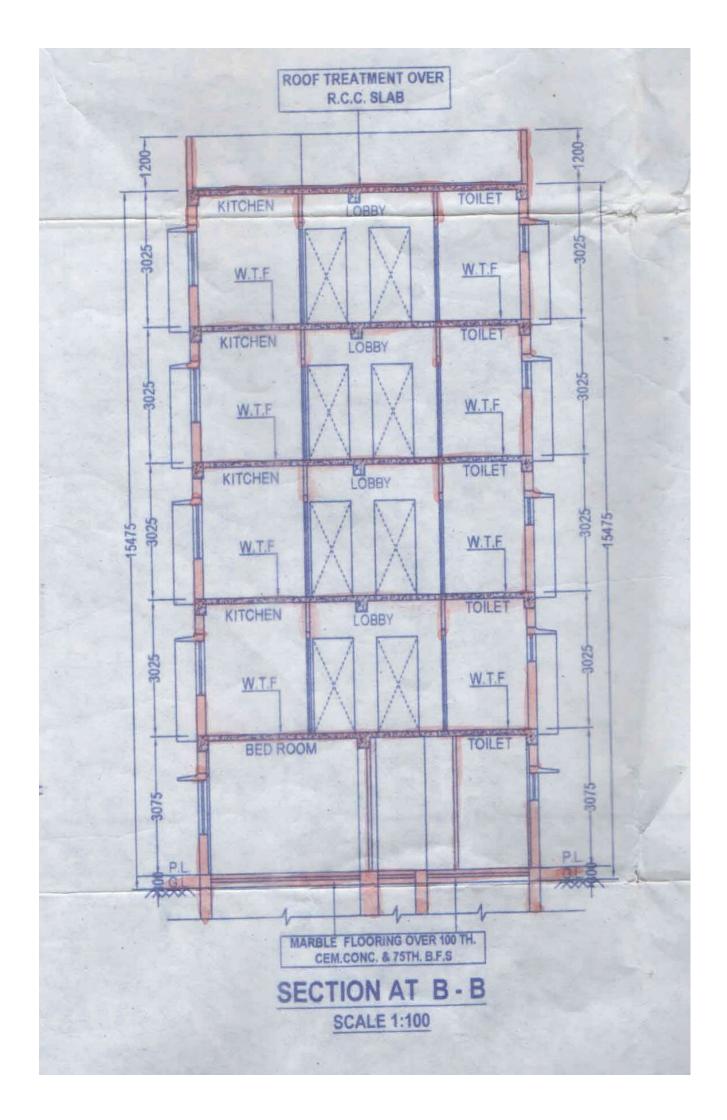

# (A) AREA STATEMENT OF OWNER (S):-

SL.	NAME OF THE OWNER	EXISTING					PROPOSED					
		USE	FLOOR	AREA (SQ. MTR.)						AREA ( SQ. MTR. )		
				OCCUPIED	COMMON	TOTAL	USE	FLOOR		OCCUPIED COMMON		TOTAL
i.	OWNER	RESIDENTIAL	Gr.FL.	24.480 + 34.670 + 223.230 + 81.250 = 363.630	10.077	373.707	RESIDENTIAL	FLOOR	2A	73.586	2.112	75.698
			Mezz.FL						2B 2C	37.307	1,070	38.377
			1ST. FL.							75,327	2.161	77.488
							TOTAL (2A + 2B + 2C)		C)	186.220	5.343	191.563
			2ND. FL.				DECIDENTIAL	3RD	3A	49,319	1.415	50.734
					TOTAL (A)	RESIDENTIAL FLOOR 3B 136.90			136.901	3.929	140.830	
							TOTAL (3A + 3B)			186.220	5.344	191.564
							RESIDENTIAL	4TH. FLOOR	4B	49,661	1.425	51,086
									TOTAL (4B)	51.086		
							RESIDENTIAL	1ST FLOOR	IA.	73.586	2.112	75.698
					TOTAL (1A)							
			1			-				1111		75.698

### (B) AREA STATEMENT OF TENANTS :-

SL.	NAME OF THE TENANTS	EXISTING					PROPOSED					
		USE	FLOOR	AREA ( SQ. MTR. )				F. D. D.		AREA (SQ. MTR.)		
				OCCUPIED	COMMON	TOTAL	USE	FLOOR		OCCUPIED	COMMON	TOTAL
ii.	SUDHIR MAJUMDER NOW SAIBAL MAJUNDER SON OF LATE SUDHIR MAJUMDER	RESIDENTIAL	Gr.FL.	78.977	2.188	81.165	RESIDENTIAL	4TH. FLOOR	4A	73.586	2.112	75.698
								TOTAL (4A)				75.698
iii.	SUNITA SEN (S.SEN)	RESIDENTIAL	Gr.FL.	143.361	3.972	147.333	RESIDENTIAL	4TH FLOOR	4C	62.973	1.807	64.780
								GR FLOOR GA		69.090	1,985	71.075
							TOTAL (4C + GA) 132,063			3.792	135.855	
	DR. C.C.DEB NOW ANJALI DEB WIFE OF DR. C.C.DEB	RESIDENTIAL 2ND. F	76	102.762	2.847	105.609	RESIDENTIAL	187	1B	49.661	1.425	51.086
iv.			2ND. FL.					FLOOR	10	62.973	1.807	64.780
							TOTAL	(1B+1C)		112.634	3.232	115,866
				AL VALUE	TOTAL (C)	334.107					TOTAL (D)	327.419

EXISTING EXEMPTED AREA = 37.974 SQ MTR

PROPOSED EXEMPTED AREA = 77.965 SQ MTR

REGISTERED TENANT DECLARATION REF. BOOK NO.- I, VOLUME NO.- 1903 - 2022 , PAGE NO. - 212017 TO 212027 BEING NO.- 190303727, FOR THE YEAR - 2022 A.R.A - III KOLKATA . DATED - 24.03:2022

## AREA STATEMENT F.A.R CALCULATION

- 1. a. AREA OF LAND (AS PER DEED) = 05 K. - 1CH. - 22 SFT. = 340.673 SQ. MTR.
  - b. AREA OF LAND ( AS PER PHYSICAL MEASUREMENT ) = 05 K. - 1 CH. - 22 SFT. = 340.658 SQ. MTR. = 3667 SQ. FT

STRIP OF LAND AREA = 12.360 SQ MTR NET AREA OF LAND = 340.658 - 12.360 = 328.298 SQ MTR

- 2. PER. GR. COVERAGE = 204.395 SQ.MT. (60 %)
- 3. EXISTING COVERED AREA (INCLUDING STAIR CASE) :-GROUND FLOOR = 267,890 SQ MTR FIRST FLOOR = 236.149 SQ MTR SECOND FLOOR = 207.079 SQ MTR MEZZANINE FLOOR = 34.670 SQ MTR TOTAL = 745.788 SQ MTR
- 4. EXISTING STAIR CASE AREA = 12.919+12.919+12.136 = 37.974 SQ.MT.
- 5. TOTAL EX. FL, AREA ( EXCLUDING STAIR CASE) = (745.788 - 37.974) = 707.814 SQ.MT.
- 6 EXISTING F.A.R = 707.814 / 340.658 = 2.078
- 7. PER. F.A.R. = (334.107 X 2) + 373.707 / 340.658 = 3.059
- 8. PROP. GROUND FLOOR AREA = 204.283 SQ MTR (59.995 %)
- 9. PROPOSED COVERED AREA (INCLUDING STAIR CASE) :-
  - 1. PROP. GR. FLOOR AREA = 204.283 SQM.
  - 2. PROP. FIRST FL. AREA = 201.813 SQM.
  - 3. PROP. SECOND FLAREA = 201.813 SQM.
  - 4. PROP. THIRD FL. AREA = 201.813 SQM
  - 5. PROP. FORTH FL. AREA = 201.813 SQM TOTAL = 1011.535 SQ MTR
- 10. TOTAL STAIR CASE & LIFT LOBBY AREA (EXEMPTED) STAIR CASE AREA = (4.7 × 2.7)

= 12.690 X 5 = 63.450 SQ MTR

LIFT LOBBY AREA = (1.350 X 2.150) = 2.903 X 5 = 14.515 SQ. MTR TOTAL EXEMPTED AREA = 63.450 + 14.515 = 77.965 SQ MTR

- 11. TOTAL COVER AREA EXCLUDING STAIR CASE & LIFT LOBBY (EXEMPTED) = 1011.535 - (63.450 + 14.515) = 933.570 SQ. MT.
- 12. PROP. F.A.R = 933.570 94.364 (CAR PARKING) = 839.224 / 340.658 = 2.4635

- a) ASSESSEE NO. 110100400352
- b) DET. OF REGD. DEED : -1. Book No. - I, Being No. - 08006, Volume No. - 82, Pages- 1280 to 1293,

Year- 2008

ADDITIONAL REGISTRAR OF ASSURANCE OFFICE OF THE A.R.A.- II KOLKATA DATED - 11 / 06 / 2009

- C) DETAIL OF POWER OF ATTORNEY :-BEING NO. - 190302884, BOOK NO. - IV VOL.NO. - 1903-2018 PAGE NO. - 84335 to 84354 ADDITIONAL REGISTRAR OF ASSURANCE OFFICE OF THE A.R.A.- III KOLKATA DATED - 16 / 05 / 2018
- D) AREA OF LAND :- 340.658 SQ MTR
- E) NO. OF STOREY = (GHV)
- F) NO. OF. TENEMENT :- 12 NOS
- G) SIZE OF, TENEMENT :-0 < 50 = 1 NOS 50 < 75 = 6 NOS
- 75 < 100 = 4 NOS 100>200 = 1 NOS
- H) AREA OF STAIR CASE COVER :- 15.810 SQ MTR
- 1) AREA OF O.H. TANK :- 6.405 SQ MTR
- J) AREA OF LIFT MACHINE ROOM 10.478 SQ MTR
- K) AREA OF C.B = 10.260 SQ MTR
- L) NET GROUND FLOOR AREA = 204.284 (12.690 +2.903 = 188 691 SQ MTR
- M) CAR PARKING REQUIRED = 50% = 94,364 SQ MTR
- N) CAR PARKING PROVIDED = 96.240 SQ MTR ( 50.377%
- O) EXISTING TOTAL TENANT AREA (EXCLUDING STAIR CASE)

= 338.955 SQ MTR (46.861%)

P) EXISTING TOTAL OWNER AREA = 384 355 SQ MTR

SPECIFICATIONS: 1. ALL THIMPNSION ARE IN MM 2. GRADE OF CONCRETE IS M 20, & THAT OF STEEL IS Fe-415 3.FOR SPECIFICATION & WORKMANSHIP NBC, 2005. 4. ALL BRICKWORK SHALL BE OF 1ST CLASS BRICKS IN CEMENT MORTAR OF RATIO 1:6 / 1:5 FOR 200 Th. WALLS 1:4 FOR 75 Th. B/ WORK 5. P.C.C. OR DAMP PROOF COURSE SHALL BE OF P.C.C. OF RATIO 1:24 WITH OTHER WATER PROOFING COMPOUND.

#### CERTIFICATE OF L.B.S.

CERTIFIED WITH FULL RESPONSIBILITY THAT THE BUILDING PLAN HAS BEEN DRAWN AS PER PROVISION OF K.M.C. BUILDING RULE 2009 AS AMMENDED FROM TIME TO TIME ALONG IN COMPLIANCE WITH RULE 142 OF K.M.C. BUILDING RULE 2009 (WITH FEW INFRINGEMENTS) AND THE SITE CONDITION INCLUDING THE WIDTH OF THE ROAD CONFORM WITH THE PLAN AND IT IS A BUILDABLE SITE AND NOT A TANK OR FILLED UP LAND. THE PLOT IS DEMARCATED BY (BOUNDARY WALL) AND EXISTING STRUCTURE.

Sibabrata Chakraborty
REGD. CIVIL ENGINEERS IN
KOLKATA MPL. CORPORATION
NO. 1/1120

SIGNATURE OF L.B.S.
SIBABRATA CHAKRABORTY L.B.S. NO.-1/1120

#### CERTIFICATE OF STRUCTURAL ENGINEER-

STRUCTURAL DESIGN AND DRAWING OF BOTH FOUNDATION AND SUPER STRUCTURE OF THE PROPOSED BUILDING WILL BE MADE. BASED ON SOIL TEST REPORT WHICH WILL BE DONE AFTER DEMOLITION OF EXISTING BUILDING, BY CONSIDERING ALL POSSIBLE LOADS INCLUDING SEISMIC LOAD AS PER PREVAILING I. S. CODES AND N.B.C. OF INDIA AND CERTIFIED THAT THE DESIGN WILL BE CALCULATED IN SUCH A WAY TO MAKE THE PROPOSED CONSTRUCTION SAFE AND STABLE IN ALL RESPECT.

Satyabrata Chakrabarti, AMIE (I) Empanelled Structural Engineer in Kol. Mpl. Corporation E.S.F. 11-650

SIGNATURE OF STRUCTURAL ENGG. SATYABRATA CHAKRABARTI . E.S.E. NO.- II / 650

# CERTIFICATE OF GEO. TECHNICAL ENGINEER-

UNDERSIGNED HAS INSPECTED THE SITE. SOIL EXPLORATION WILL BE CARRIED OUT AT SITE AFTER DEMOLITION OF EXISTING STRUCTURE. SOIL EXPLORATION REPORT WITH RECOMMENDATION WILL BE SUBMITTED ACCORDINGLY. NOW IT IS CERTIFIED THAT SOIL EXPLORATION AND RECOMMENDATION REPORT WILL BE COMPARED AND VERIFIED BY ME WITH PROPOSED CONSTRUCTION TO THE CONSTRUCTION SO THAT THE SITE WILL ABLE TO CARRY THE LOAD COMING FROM PROPOSED CONSTRUCTION TO THE FOUNDATION. CERTIFIED THAT THE RECOMMENDATION FOLLOWED WITH SOIL EXPLORATION WILL BE MADE IN SUCH A WAY TO MAKE THE PROPOSED CONSTRUCTION SAFE AND STABLE IN ALL RESPECT FROM GEO-TECHNICAL POINT OF VIEW.

RUPAK KUMAR BANERJEE
B.C.E., M.E., MIGS
M.I.E., CHARTERED ENGINEER
ENLISTED GEO TECHNICAL ENGINEER (K.M.C.)
G.T.JI/3 (K.M.C.) LM-4279, M.-153878-5

SIGNATURE OF GEO TECHNICAL ENGINEER
RUPAK KUMAR BANERJEE (GT/103)

## DECLARATION OF OWNERS APPLICANT-

PRESENT STATUS AND PROPOSED ACCOMMODATION OF TENANT(S) DRAWN BY L.B.S. AS PER THE CLARIFICATION AND EXPLANATION AND PHOTOCOPY OF DOCUMENTS SUPPLIED BY OWNER (S) AND OWNER(S) WILL BE HELD AS SOLE RESPONSIBLE FOR ANY MISREPRESENTATION OF FACT AND SUBSEQUENT LITIGATION FOR THE SAME.

harm transfer

SRI TARUN BANERJEE PROPRIETOR OF -KAIZEN BUILDOON AS CONSTITUTED ATTORNEY OF SRI SAMIT MITTER

SIGNATURE OF OWNERS / APPLICANT
SRI TARUN BANERJEE PROPRIETOR
OF KAIZEN BUILD CON CA TO SRI SAMIT KUMAR MITTE

PROPOSED PLAN OF G+ IV STORIED RESIDENTIAL BUILDING OF HEIGHT

15.475 MTR FOR SANCTION U / S - 393 OF K.M.C ACT 1980. AND U / R - 142 OF K.M.C

BUILDING RULE 2009. READ WITH RELEVANT OFFICE CIRCULARS AT

PREMISES NO. 13 / 1 B, BALARAM GHOSH STREET, WARD NO. - 010,

BR. NO.+ II, P.S - SHYAMPUKUR, KOLKATA - 700 004.



S. CHAKRABORTY & ASSOCIATES 21 A BALARAM GHOSH STREET KOLKATA - 700 004 MOB NO - 9830736094 8910901128

SCALE = 1:100, 1:605, 1:4000, 1:60 ALL DIMENSIONS ARE IN MM. DRAWN BY - SUKANTA PAUL

- A. Preventive measures need to be taken for pollution tree environment:-
- a) wrap construction area/ buildings with geotextile fabric installing dust barriers, or other actions as appropriate for the location.
- Apply water and maintain soils in a visible damp or crusted condition for temporary stabilization.
- Apply water prior to leveling or any other earth moving activity to keep the soil moist throughout the process;
- d) Limit vehicle speeds to 15 mph on the work site.
- e) Clean wheels and undercarriage of haul trucks prior to leaving construction site.
- f) Apply and maintain dust suppressant on haul routes.
- g) Apply a cover or screen to stockpiles and stabilize at completion of activity by water and maintain a dust palliative to all outer surfaces of the stockpiles;
- h) Stabilize surface soils where loaders, support equipment and vehicles will operate by using water and maintain surface soils in a stabilized condition where loaders, support equipment and vehicles will operate:
- Stabilize adjacent disturbed soils following paving activities with immediate landscaping activity or installation of vegetative or rock cover.
- j) Maintain dust control during working hours and clean track out from paved surfaces at the end of the work shift/day. Track out must now extend 50 feet or more and must be cleaned dally, at the minimum.
- k) Stabilize sloping surfaces using soil binders until vegetation or ground cover effectively stabilize the slope.
- Disposal of debris in consultation with the local authorities following proper environmental management practice.
- m) During construction work, including cutting of marbles, ambient noise level should not exceed more than 65 dB(A).
- B. Practices to be discarded for pollution free Environment:-
- a) Don't dispose of debris indiscriminately,
- b) Don't allow the vehicles to run at high speed within the work site.
- c) Don't cut materials without proper dust control/noise control facility.
- d) Don't keep materials without effective cover.
- e) Don't allow access in the work area except workers to limit soil disturbance and prevent access by fencing, ditches, vegetation, berms or other suitable barrier.
- f) Don't leave the soil, sand and cement stack uncovered.
- g) Don't keep materials or debris on the roads or pavements.
- Burning of old tyres in hot mix plant as a fuel during construction and repair of the road melting coal tar should be discarded.

air of the roads to Br. The Part Incent

# PARTY'S COPY

RESIDENTIAL BUILDING

Ne rain water pipe should be fixed or discharged en Road or Feotpath.

Brainage plan should be submitted at the Borough Executive Engineer's Office and the sanction obtained before proceeding with the drainage work.

BUILDING PERMIT
No. 20 220 20005
Date 28-04-22 Borough No. II
Ex. Engineer / Asst. Engineer
Bor. Ne. III. Bor. No. II

BUILDING DEPARTMENT

THE SANCTION IS VALIED UP TO 27 - 09 - 2027

Before starting any Construction the site must conform with the plans sanctioned and all theconditions as proposed in the planshould be fulfilled.

The validity of the written permission to execute the work is subject to the above conditions.

Necessary steps should be taken for the safety of the lives of the adjoining public and private properties during construction.

All Building Materials to necessary & construction should conform's to standard specified in the National Building Code of India.

Non Commencement of Erection/ Re-Erection within Five year will Require Fresh Application for Sanction

Approved By: Mr. B. C. Meelin No: 591
The Building Committee
No: 178 21-22

Sanctioned subject to demolition of existing structure to provide open space as per plan before construction is started

Executive Engineer (C)

Asst Engineer (C)
Br. PLAN TI

A suitable pump has to be provided i.e. pumping unfiltered water for the distribution to the flushing cisterns and urinals in the building incase unfiltered water from street main is not available.

Plan for Water Supply arrangement including SEMILI G & O. H. reservoirs should be submitted at the Office of the Ex-Engineer Water Supply and the sanction obtained before proceeding with the work of Water Supply any beviation may lead to disconnection / demolition

CONSTRUCTION SITE SHALL BE MAINTAINED TO PREVENT MOSQUITO BREEDING AS REQUIRED U/S 496 (1) & (2) OF CMC ACT 1980, IN SUCH MANNER SO THAT ALL, WATER COLLECTION & PARTICULARLY LIFT WELLS, VATS, BASEMENT CURING SITES, OPEN RECEPTACLES ETC. MUST BE EMPITED COMPLETELY TWICE A WEEK.

The building materials that will be stacked on Road/Passage or Foot-path beyond 3-months or after construction of G. Floor, whichever is earlier may be seized forthwith by the K.M.C. at the cost and risk of the owner.

The sanction refers to the proposed portion shown in red and the Executive Engineers makes no admission as to the correctness of the plan.

Sanctioned conditionally on an undertaking duly registered from the owner's to the effect till they will not evict any tenants & will also provide the tenants with identical area in and around the premises by mutual arrangements.

Splayed portion: Sanctioned conditionally byundertaking of the owner that the splayed portionwill be free gifted to the K. M. C. and no wall can be constructed over it.

OFFICE OF THE E.E. (G) BOROUGH-II

2 2 APR 2022

Building Department K.M.C.